




LEFT SIDE ELEVATION
SCALE: 1/8"=1'-0"

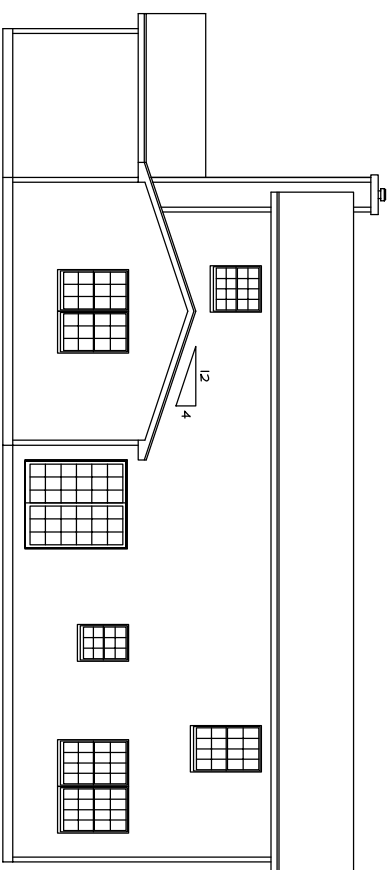

REAR ELEVATION
SCALE: 1/8"=1'-0"

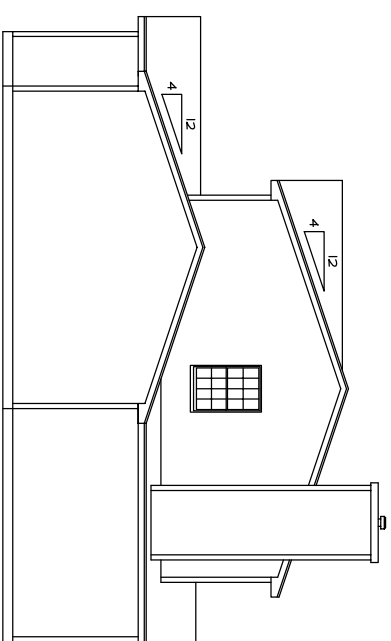

RIGHT SIDE ELEVATION
SCALE: 1/8"=1'-0"

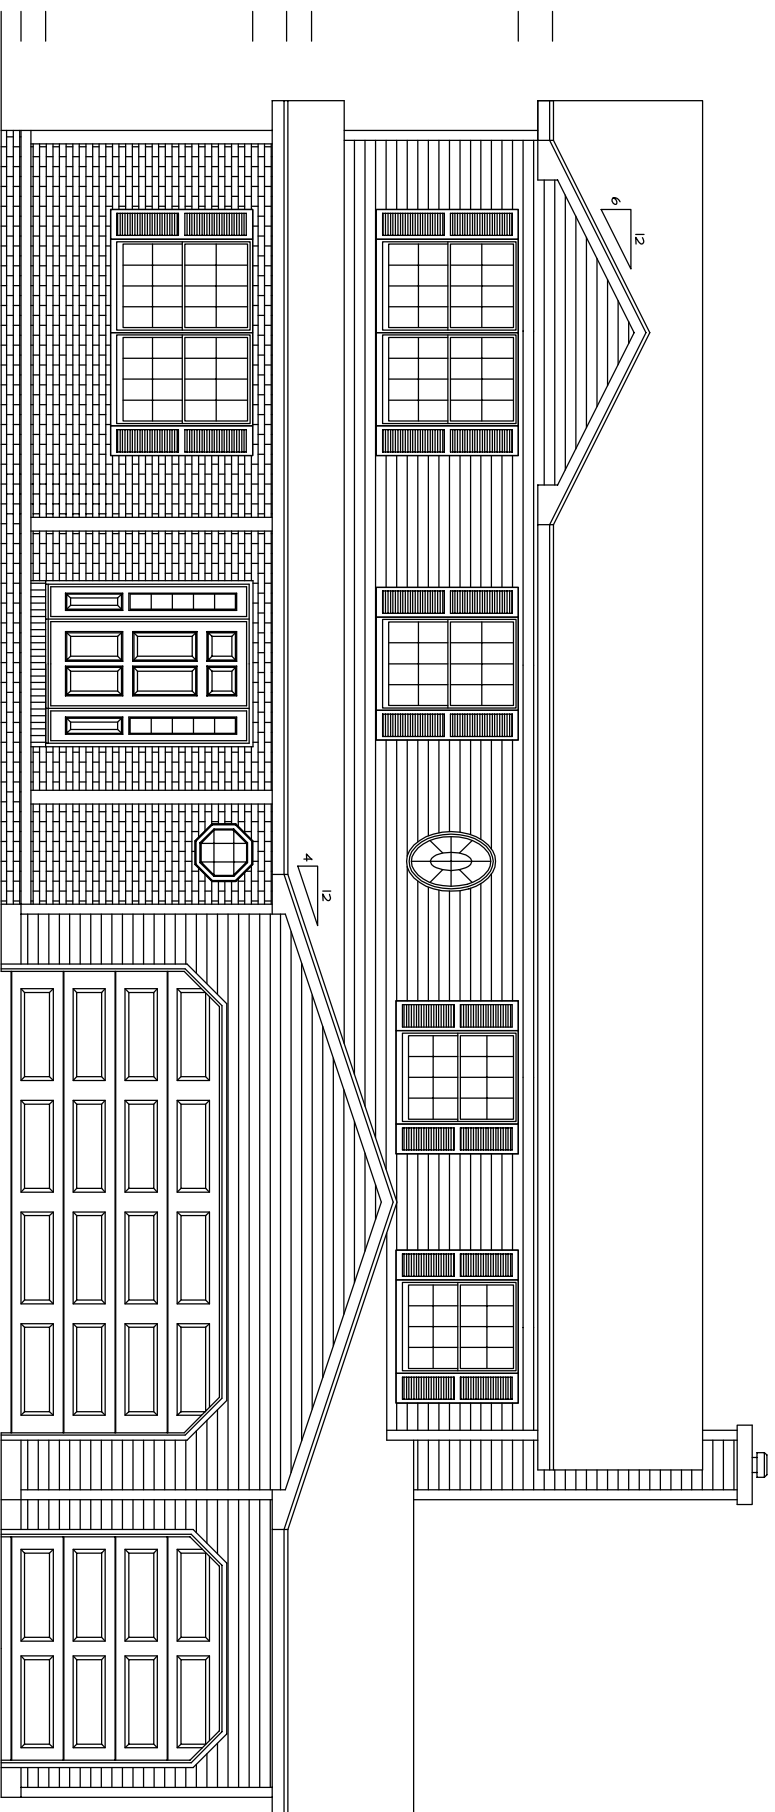

FRONT ELEVATION
SCALE: 1/4"=1'-0"

—ATTENTION—
Every attempt has been made in the preparation of this plan to avoid mistakes, but we cannot guarantee the accuracy of the drawing. It is the responsibility of the owner and/or the General Contractor to check all dimensions for the job. Caution: Always use given dimensions, never scale the drawing. All engineering of Beams & Joist Spans are the responsibility of the General Contractor.

O'Connor Homes


REVISED: 11/20/01 B.L.

DRAWING OF: ELEVATIONS SCALE: AS NOTED
DATE: 11/4/99
DRAWN BY: JW

SHEET:

1

R0218

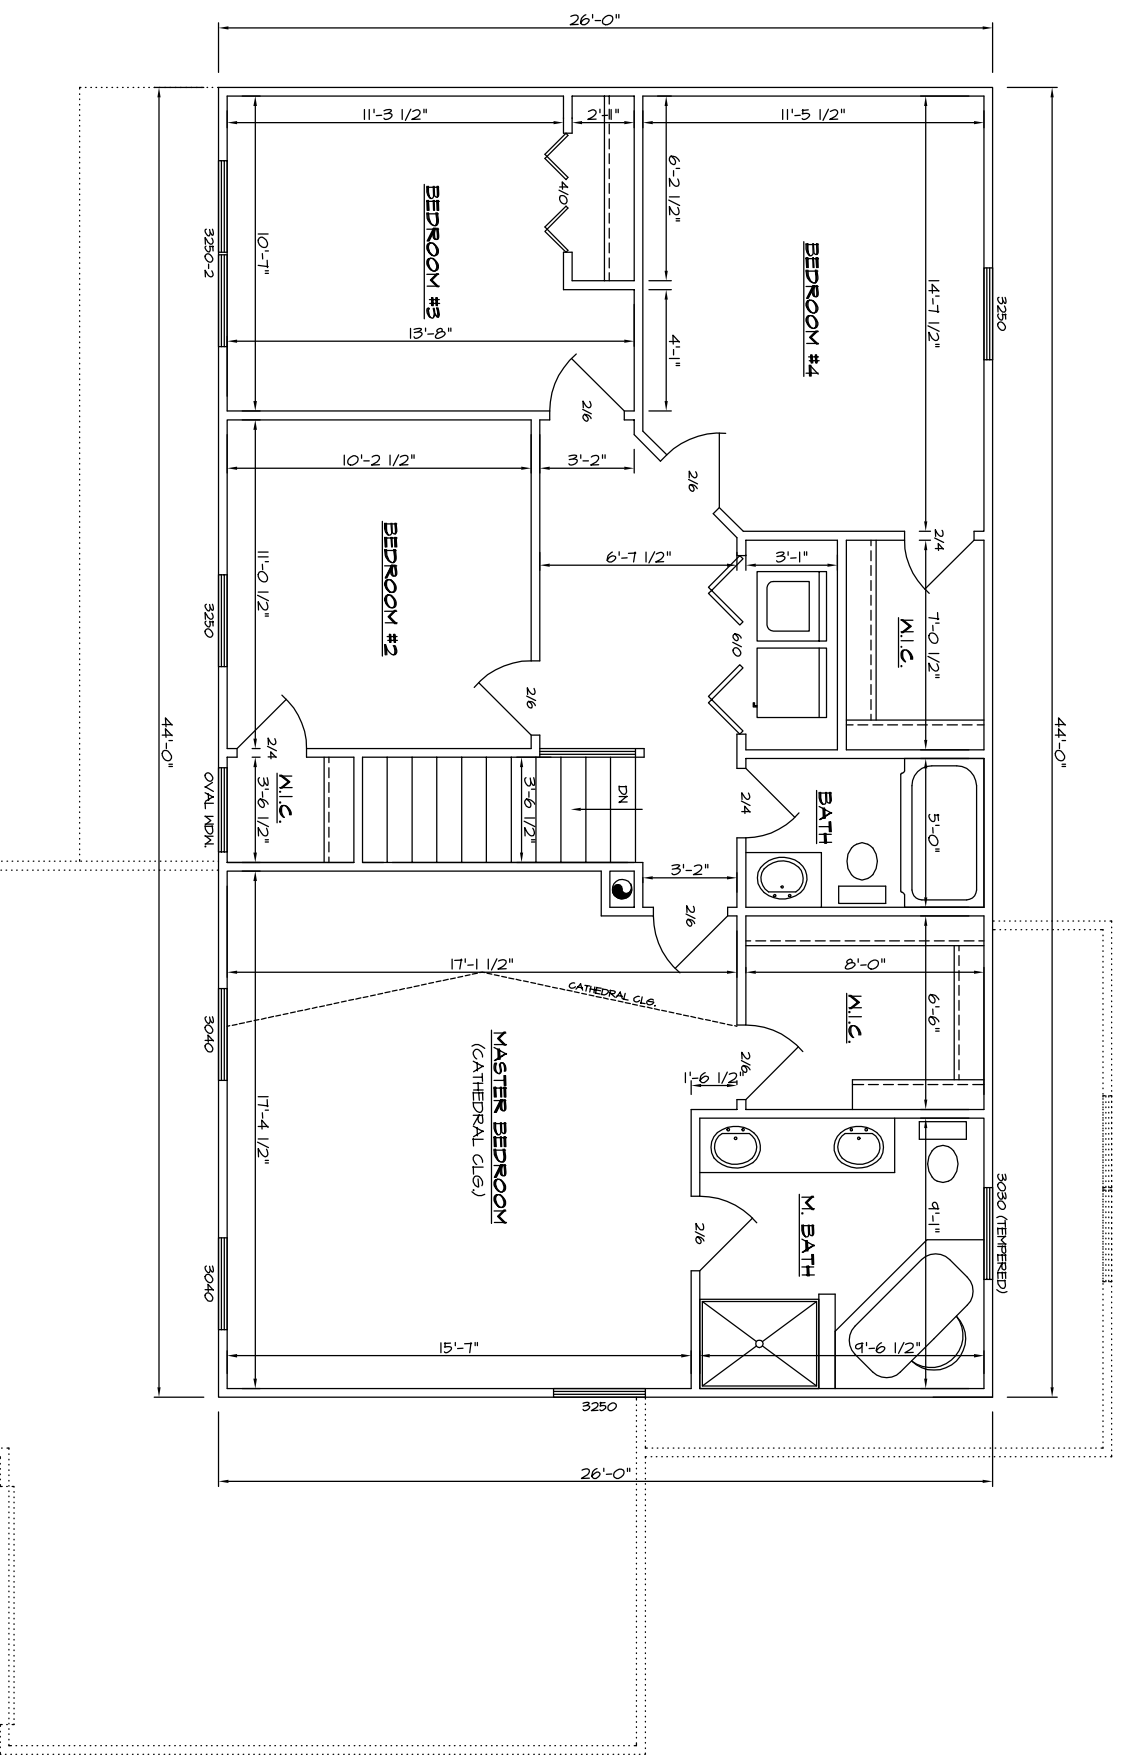


SECOND FLOOR PLAN
1144 Sq. Ft.

- NOTES**
1. ALL EXTERIOR DIMENSIONS ARE TO FACE OF STUD
 2. ALL INTERIOR DIMENSIONS ARE TO FACE OF STUD
 3. ALL WALLS TO BE 2x4 UNLESS OTHERWISE NOTED
 4. ALL CEILINGS TO BE 8'-1 1/8" HIGH

-ATTENTION-

Every attempt has been made in the preparation of this plan to avoid mistakes, but we cannot guarantee the accuracy of the dimensions shown. It is the responsibility of the owner and/or the General Contractor to check all dimensions for the job. Caution: Always use given dimensions, never scale the drawing. All engineering of Beams & Joist Spans are the responsibility of the General Contractor.

O'Connor Homes		REVISED: 11/20/01 B.L.	
DRAWING OF: SECOND FLOOR PLAN	SCALE: 1/4"=1'-0"	SHEET:	
DATE: 11/4/99		3	
DRAWN BY: JW			

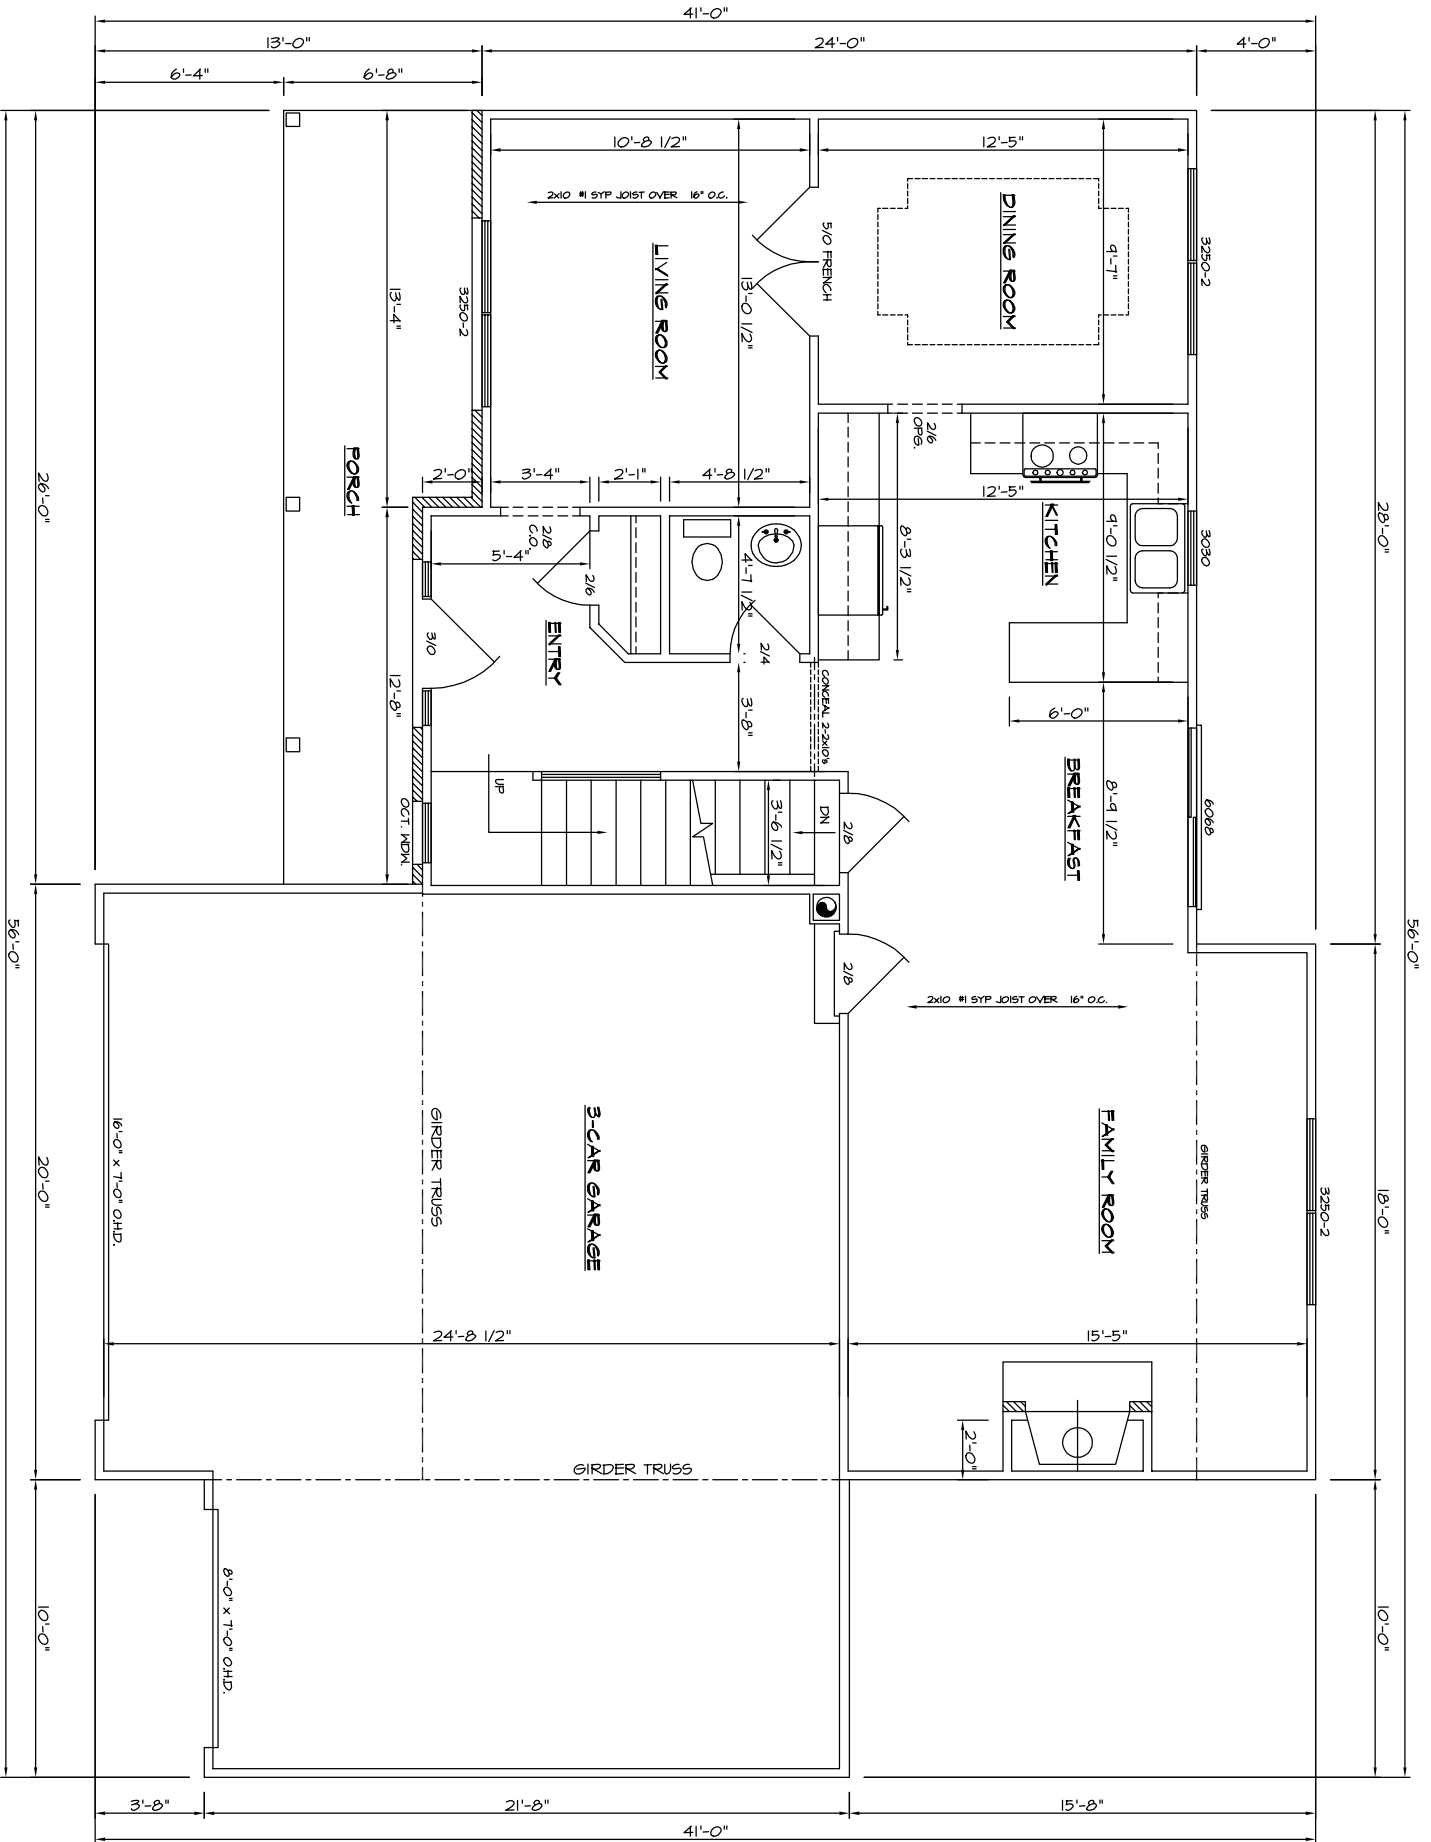

FIRST FLOOR PLAN

944 Sq. Ft.

- NOTES**
1. ALL EXTERIOR DIMENSIONS ARE TO FACE OF STUD
 2. ALL INTERIOR DIMENSIONS ARE TO FACE OF STUD
 3. ALL WALLS TO BE 2x4 UNLESS OTHERWISE NOTED
 4. ALL CEILINGS TO BE 8'-1 1/8" HIGH

-ATTENTION-
 Every attempt has been made in the preparation of this plan to avoid mistakes, but we cannot guarantee the accuracy of the drawing. It is the responsibility of the owner and/or the General Contractor to check all dimensions for the job. Caution: Always use given dimensions, never scale the drawing. All engineering of Beams & Joist Spans are the responsibility of the General Contractor.

<h2>O'Connor Homes</h2>		REVISED: 11/20/01 B.L.
		DRAWING OF: FIRST FLOOR PLAN
DATE: 11/4/99	SCALE: 1/4"=1'-0"	SHEET:
DRAWN BY: JW		2